B-3 1 of 22

SUBDIVISION REVIEW SHEET ENVIRONMENTAL VARIANCE REQUEST ONLY

CASE NO.: C8-2019-0080.1B.SH **Z.AP. DATE:** 01/05/2021

SUBDIVISION NAME: Persimmons Construction Plans

AREA: 2.12 acres **LOT(S)**: Right-of-Way

OWNER/APPLICANT: AGENT: Dario Octaviano June Routh

City of Austin Public Works
Dunaway Associates
(512) 974-7607
(512) 399-5366

ADDRESS OF SUBDIVISION: 7051 Meadow Lake Blvd., Austin, TX 78744

WATERSHED: Onion Creek **COUNTY:** Travis

EXISTING ZONING: SF-6 **JURISDICTION:** Full-purpose

NEIGHBORHOOD PLAN: N/A

PROPOSED LAND USE: Public right-of-way

<u>VARIANCES</u>: To cut more than four feet in depth within 100 feet of a classified waterway

(LDC 25-8-341)

DEPARTMENT COMMENTS: Recommend, see Environmental Officer memo (page 2)

STAFF RECOMMENDATION: Having redesigned the project to include a stream restoration project in the area of the requested variance, staff now recommends approval of the requested variance with the condition the applicant complete the stream restoration project as designed in accordance with WPD and DSD coordination (see pages 15-21 of the variance packet).

CASE MANAGER: Danielle Guevara **PHONE:** (512) 974-3011

Email address: Danielle.Guevara@austintexas.gov

B-3 2 of 22



MEMORANDUM

T0: Chair Kiolbassa and Members.

Austin Zoning and Platting Commission

Christopher Herrington, P.E., Environmental Officer FROM:

Watershed Protection Department

DATE: December 17, 2020

Revised staff recommendation for the Persimmon Construction Plan **SUBJECT:**

environmental variance request, C8-2019-0008.1B.SH

The purpose of this memo is to provide a revised staff recommendation on the request to vary cut requirements, City Code 25-8-341 (Cut Requirements), for the Persimmons Construction Plan project, case C8-2019-0080.1B.SH. Based on changes proposed by the applicant to now include additional stream restoration, staff now recommends the variance, having determined that the required findings of fact have been met.

The applicant originally sought to extend Meadow Lake Blvd across a waterway, involving cut more than 4 feet within 100 feet of a classified waterway. Staff previously recommended denial of the variance, having determined that the required findings of fact per City Code 25-8-41 (Land Use Commission Variances) had not been met. More specifically, the original variance request was a design decision made by the applicant that did not achieve greater overall environmental protection. The variance request was considered by the Environmental Commission on May 20, 2020, and they recommended denial of the variance request.

Since consideration by the Environmental Commission, the applicant (Public Works Department) has collaborated with the Watershed Protection and Development Services departments to now incorporate a stream restoration project as part of the extension of Meadow Lake Blvd. The stream restoration will enhance the existing conditions of the stream with bank stabilization and planting of vegetation, addressing existing erosion concerns that currently threaten private property and are degrading the stream.

Staff now finds that the variance request meets the required findings by providing greater overall environmental protection, and recommends approval of the variance by the Zoning and Platting Commission. I wish to thank the Public Works and Watershed Protection departments for their cooperation, and note that Jonathan Garner of the Development Services Department is deserving of special recognition for identifying and facilitating this collaboration opportunity. If you have any questions, please contact Jonathan Garner at 512-974-1665 or jonathan.garner@austintexas.gov or Chris Herrington at 512-773-2442 or chris.herrington@austintexas.gov.

B-3 3 of 22



ENVIRONMENTAL COMMISSION MOTION 20200520-006b

Date: May 20, 2020

Subject: Persimmons Construction Plans, C8-2019-0080.1B.SH

Motion by: Kevin Ramberg Seconded by: Linda Guerrero

RATIONALE:

WHEREAS, the Environmental Commission recognizes the applicant is requesting a variance from LDC 25-8-341 to allow cut in excess of four feet within 100 feet of a classified waterway.

WHEREAS, the Environmental Commission recognizes that staff does not recommend the variance having determined the findings of fact have not been met.

THEREFORE, the Environmental Commission recommends denial of the requested variance from LDC 25-8-341 to allow cut in excess of 4 feet within 100 feet of a classified waterway.

VOTE 9-1

For: Smith, Thompson, Neely, Coyne, Maceo, Ramberg, Guerrero, Gordon, and Bedford

Against: Creel Abstain: None Recuse: None Absent: Nill

Approved By:

Linda Guerrero, Environmental Commission Chair

hinds & guerrero

B-3 4 of 22

Application Form Variance to LDC 25-8-341



ENVIRONMENTAL COMMISSION VARIANCE APPLICATION FORM

PROJECT DESCRIPTION						
Applicant Contact Inform	mation					
Name of Applicant	June Routh on behalf of the City of Austin Public Works Dept (owner of ROW)					
Street Address	5707 Southwest Parkway, Ste 250, Bldg 2					
City State ZIP Code	Austin Texas 78735					
Work Phone	512-399-5366					
E-Mail Address	JRouth@DunawayAssociates.com					
Variance Case Informat	ion					
Case Name	Meadow Lake Blvd Street Extension – CIP # 6319.014					
Case Number	C8-2019-0080.1B.SH					
Address or Location	Meadow Lake Blvd – Between Misty Slope and Quicksilver Blvd					
Environmental Reviewer Name	Jonathan Garner					
Environmental Resource Management Reviewer Name						
Applicable Ordinance	LDC 25-8-42(D)(4)					
Watershed Name	Onion Creek					
Watershed Classification	□ Urban X Suburban □ Water Supply Suburban □ Water Supply Rural □ Barton Springs Zone					

Edwards Aquifer Recharge

☐ Northern Edwards Segment

Zone		X Not in Edwards Aquifer Zones					
Edwards Aquifer Contributing Zone		☐ Yes	X No				
Distance to Nearest Classified Waterway		Cut is directly in channel					
Water and Wastewate service to be provided		AWU – project is a roadway construction including an irrigation meter for landscape but no domestic service.					rigation
Request		The variance request is as follows (Cite code references: Cut in excess of 4 ft but less than 8 ft within 100 ft of a classified waterway. LDC 25-8-42(D)(4).					
Impervious cover		E	Existing			Proposed	
square footage:							-
acreage:							-
percentage:							
Provide general description of the property (slope range, elevation range, summary of vegetation / trees, summary of the geology, CWQZ, WQTZ, CEFs, floodplain, heritage trees, any other notable or outstanding characteristics of the property)	drains a box cul Meado diamet	an upstrean verts with h w Lake Blvd	of cut in excent of detention posterion of readwalls/wind roadway acro larger in the aid e project.	ond. The cut gwalls in th oss the char	t is necessary e channel to a nnel. There a	to install th allow paving re no trees	ree 9 ft x 4 ft g of the with a

☐ Barton Springs Segment

Clearly indicate in what
way the proposed project
does not comply with
current Code (include
maps and exhibits)

The 362 sq ft area of cut in excess of 4 ft is necessary for installation of drainage culverts for the Meadow Lake Blvd Road extension project. A cut and fill exhibit is attached.

FINDINGS OF FACT

As required in LDC Section 25-8-41, in order to grant a variance, the Land Use Commission must make the following findings of fact:

Include an explanation with each applicable finding of fact.

Project: Meadow Lake Blvd Street Extension - CIP # 6319.014

Ordinance: LDC 25-8-42(D)(4) – Cut in excess of 4 ft within 100 ft of a classified waterway.

- A. Land Use Commission variance determinations from Chapter 25-8-41 of the City Code:
 - 1. The requirement will deprive the applicant of a privilege available to owners of similarly situated property with approximately contemporaneous development subject to similar code requirements.

Yes / No

City of Austin regulations require that for road crossing required for connectivity that a culvert be placed at the ditch crossing which meets the City's Drainage Criteria. A minimum amount of grading is commonly required and allowed for such culvert application, which often exceeds 4 ft of cut or fill.

2. The variance:

- a) Is not necessitated by the scale, layout, construction method, or other design decision made by the applicant, unless the design decision provides greater overall environmental protection than is achievable without the variance;
 - Yes / No The location of the roadway is dictated by the existing roadway to which the proposed roadway must be connected.


- b) Is the minimum deviation from the code requirement necessary to allow a reasonable use of the property;
 - Yes / No The proposed grading results in a small area exceeding the cut limit and in a minimum departure from the code requirement.
- c) Does not create a significant probability of harmful environmental consequences.
 - Yes / No The cut area is located at the channel transition for the culvert and would not result in additional site disturbance. Revegetation would be provided for all disturbed areas.
- 3. Development with the variance will result in water quality that is at least equal to the water quality achievable without the variance.
 - Yes / No The minimal additional cut will facilitate the culvert without affecting water quality.
- В. Not Applicable


^{**}Variance approval requires all above affirmative findings.

B-3 9 of 22


Applicant Exhibits Variance to LDC 25-8-341



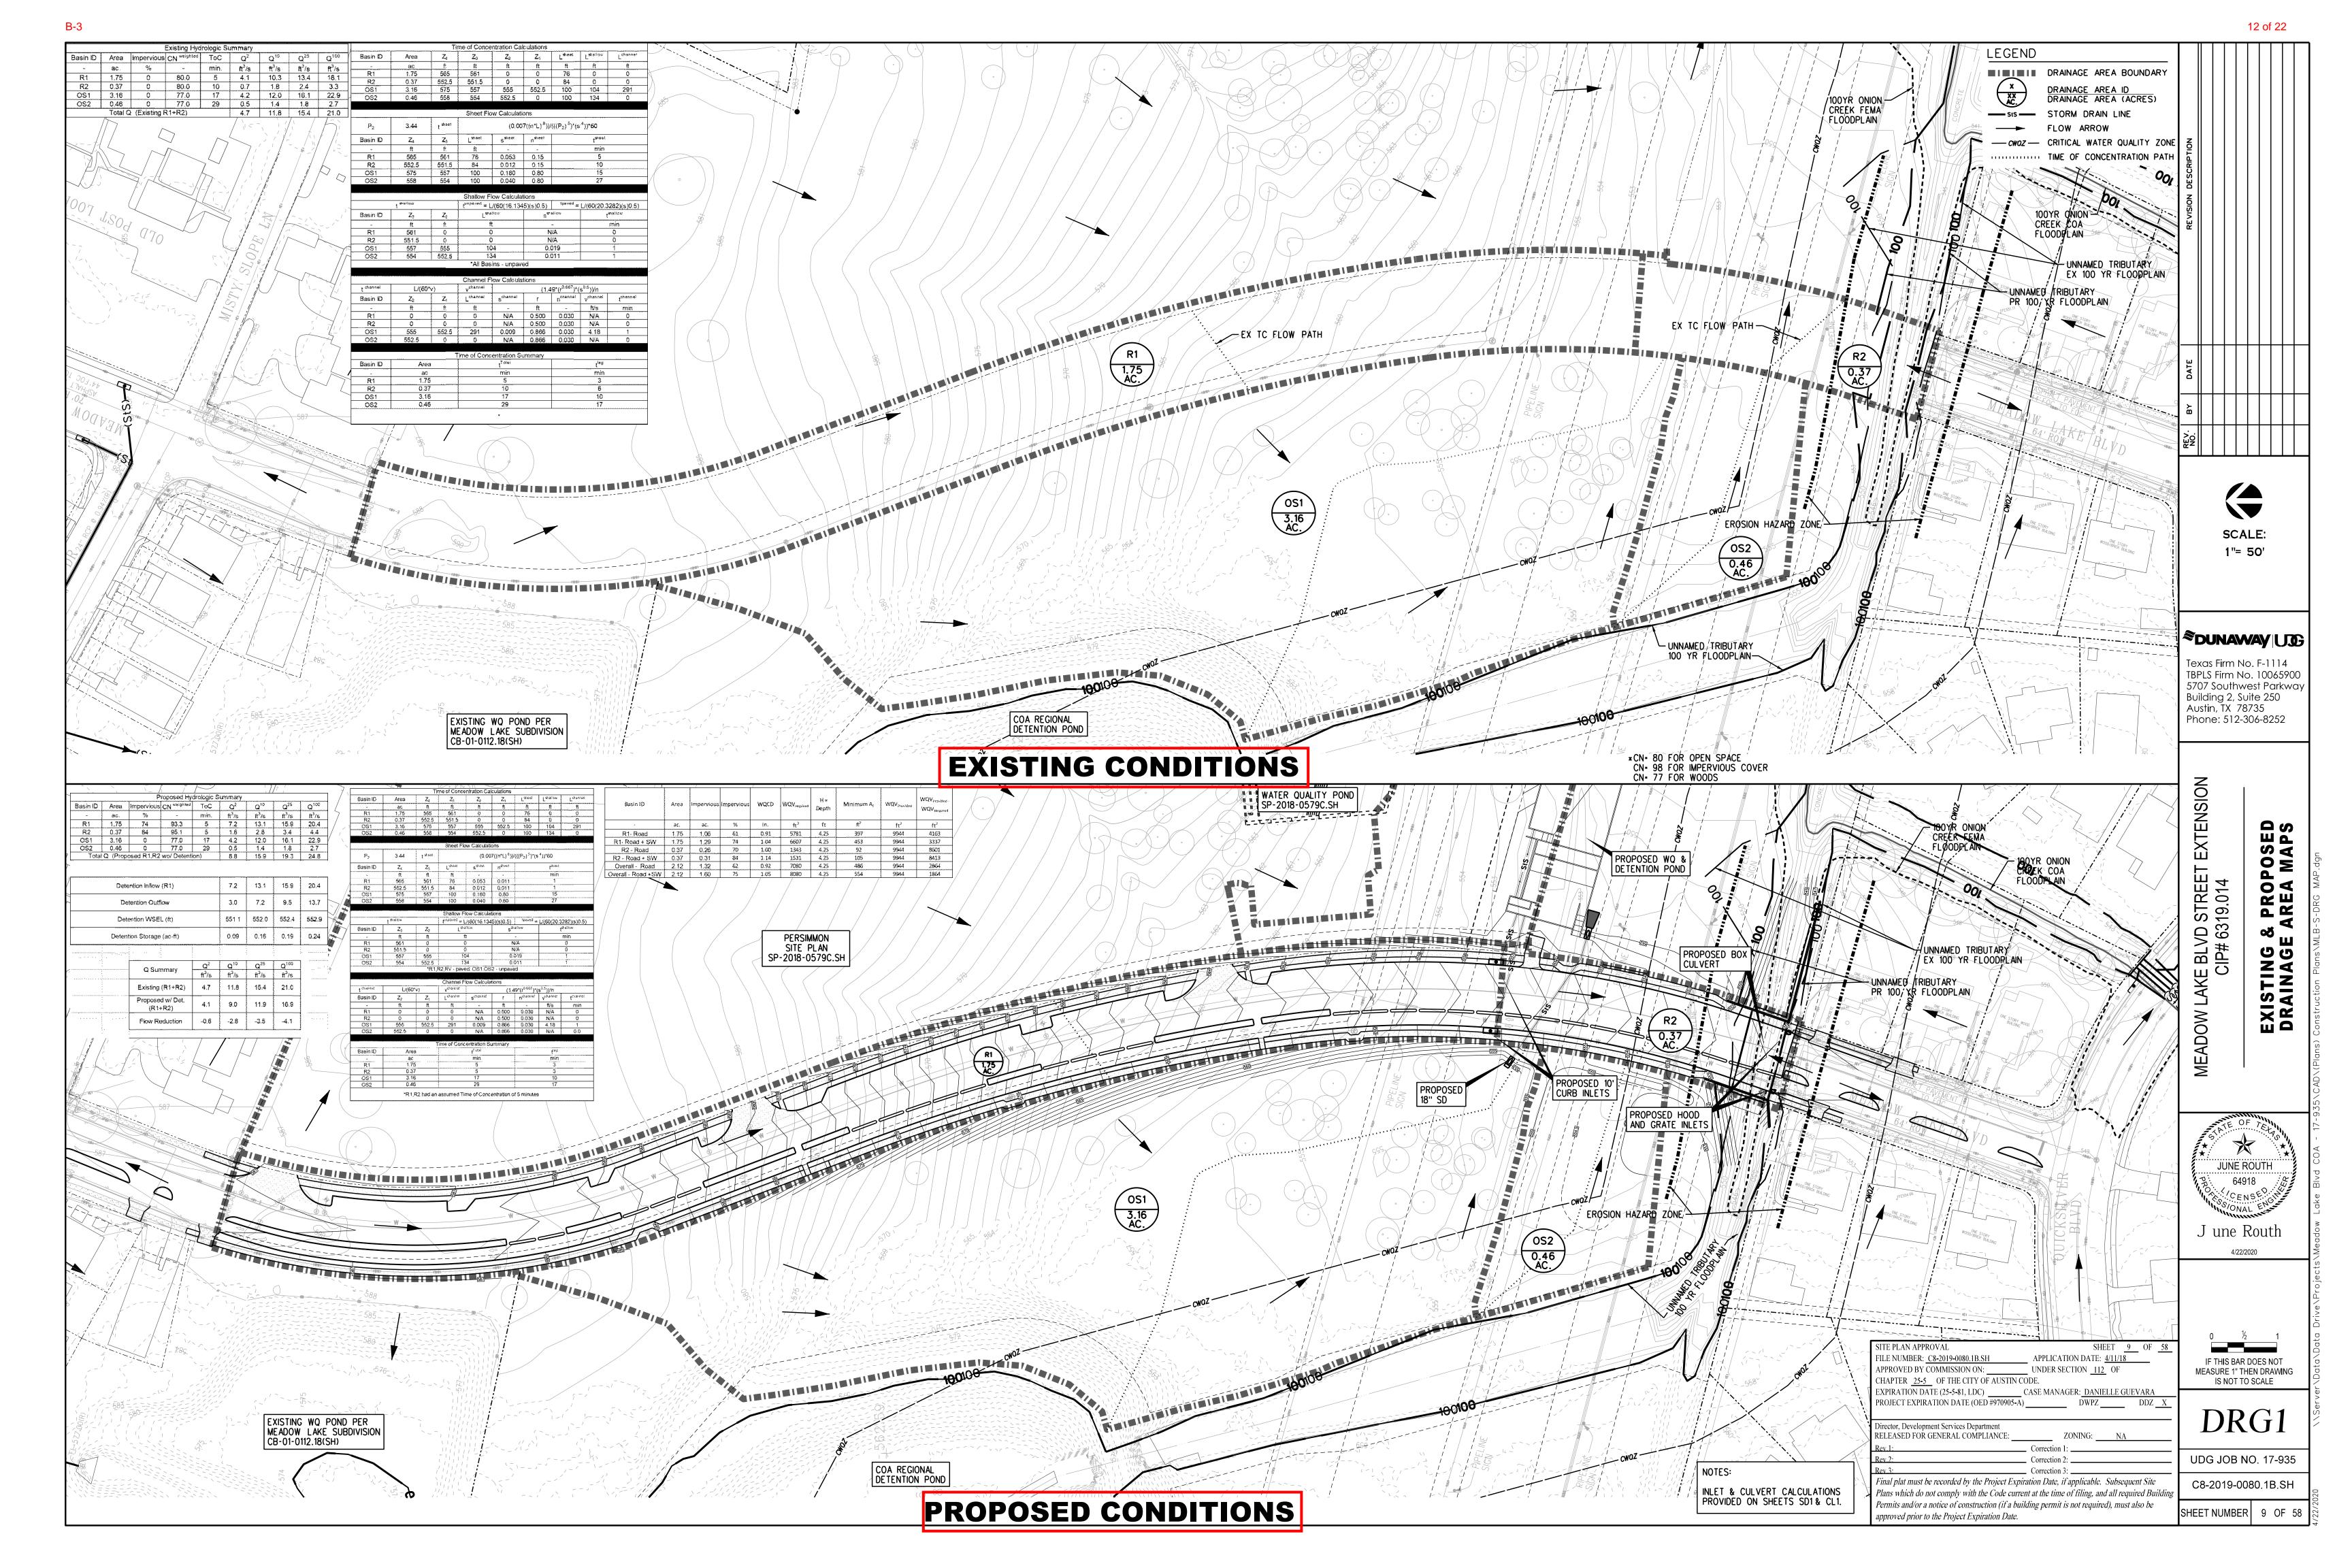

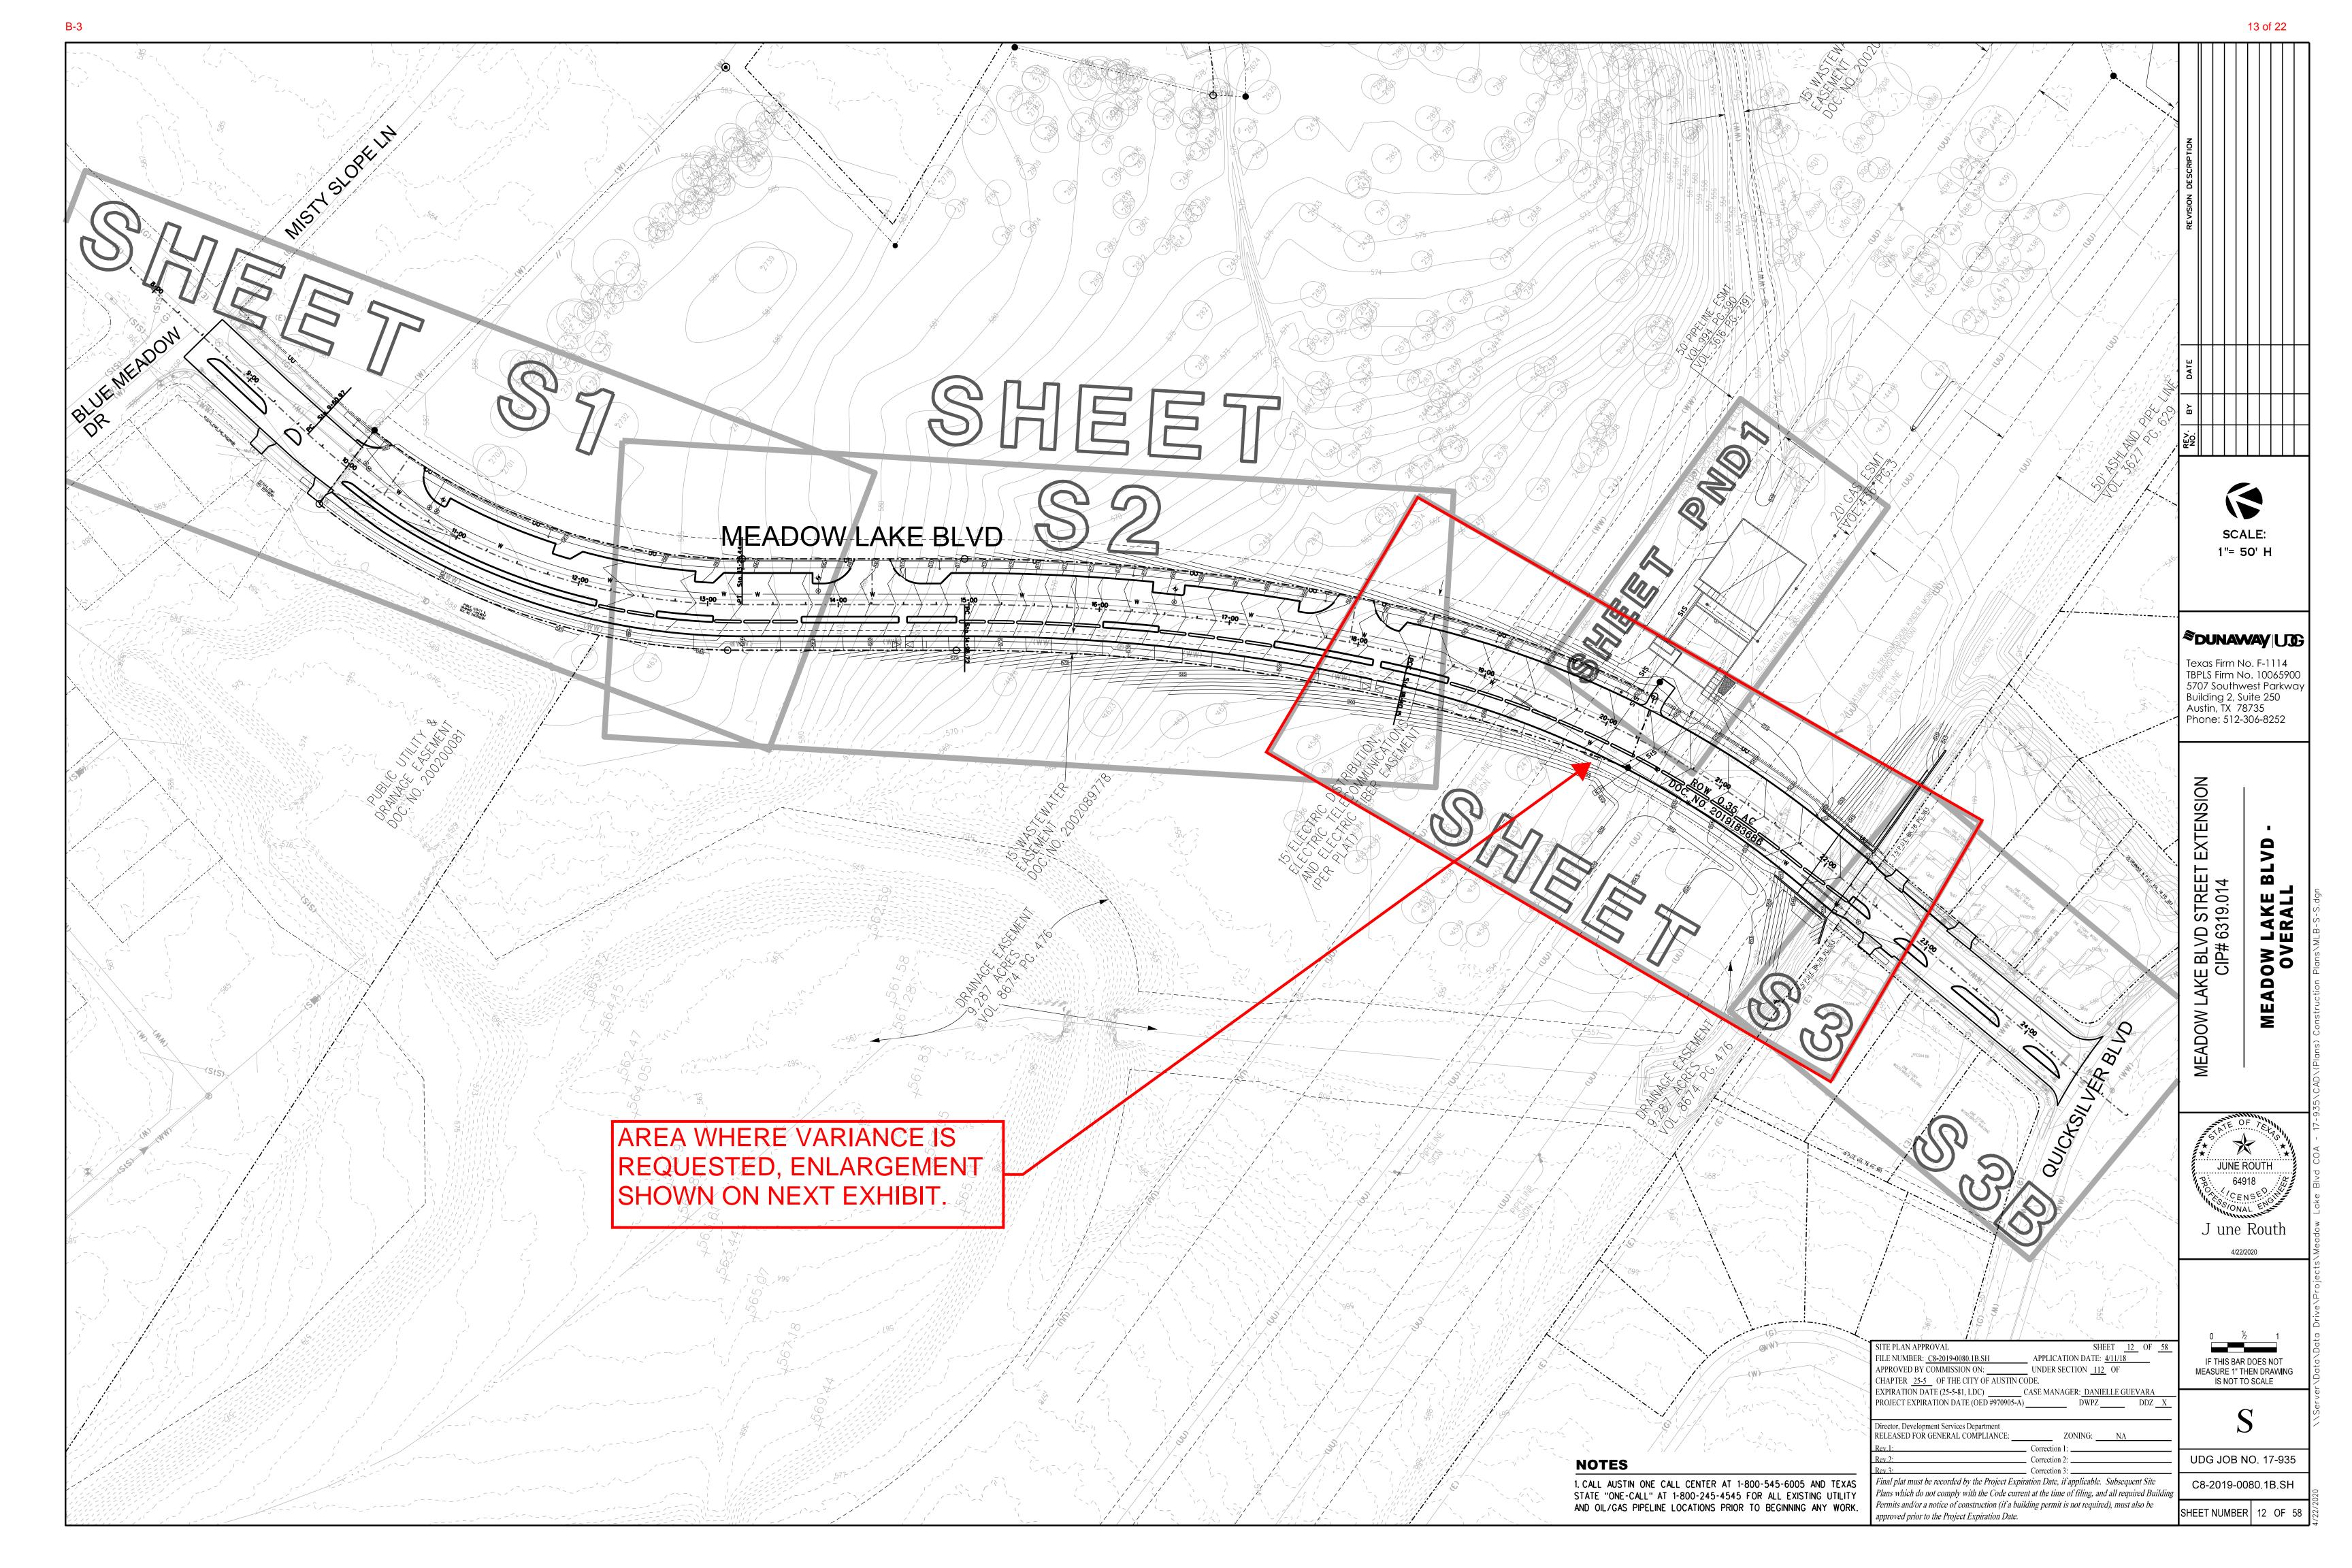

14 of 22 LOT CITY OF PROPOSED WQ / **LEGEND** 24.694 ACRES PERSIMMON DETENTION POND SHEET PND1 VOL. 10759 FG. 488 202000017 ----- BOUNDARY / ROW PERSIMMON SITE WATER LINE- EXISTING MICK BUILDING - DRAINAGE EASEMENT LOT LINE PER SUBD. PLAT SP-2018-0579C.SH water line- proposed PROPOSED 2- 2" AE CONDUIT FOR NEW STREET LIGHTS, SILVERSTONE PH. 1/SEC. PROPOSED 5' WIDTH CONCRETE SIDEWALK DTL 432S-1/SHT DTL1 WATER METER TYPICAL ,BK, 78 PG. 38/1 STREET STA 20+00.00 PROPOSED 2- 10' CURB INLET WATER VALVE 15' ELECTRIC EASEMENT -PER SUBD. PLAT (SHEET SD1) (XXXXX)WATER INTERSECTION MAP NO. PROPOSED 17"x30" HANDHOLE, TYPICAL ST REET STA 22+33.72 EX WW MH •23857 EX RIM-550.44 FIRE HYDRANT WASTEWATER LINE- EXISTING ROW PER PERSIMMON -SUBDIVISION PLAT 202000017 —(WW)— ADJUST MANHOLE TO PROPOSED FINISHED GRADE (ALJUSTMENT DETAILS, SHEETS DTL2 AND DTL3) WASTEWATER MANHOLE ----(StS)---STORM SEWER- EXISTING MEADOW LAKE BLVD STORM SEWER- PROPOSED STREET PT STA 21.91.38 STORM SEWER MANHOLE UTILITY POLE STREET LIGHT 0.35 A¢ OVERHEAD UTILITY ----(OU)-DOC. NO. 2019183686 UNDERGROUND UTILITY E (MM) 8" WW (80-0509) ELECTRIC MANHOLE PROPOS D WATER LINE, SHEET W GAS LINE ——(G)—— PAVEMENT REPAIR GEOTECH BOREHOLE BORES PER REPORT BY MLA LABS DATED 4/22/16 & 6/20/19 STREET STA 20+26.14 INSTALL TYPE II DRIVEWAY
SHEET PND3 **NOTES** PROPOSED 5' WIDTH CONCRETE SIDEWALK 1. CALL AUSTIN ONE CALL CENTER AT 1-800-545-6005 AND TEXAS STATE "ONE-CALL" AT 1-800-245-4545 © 2'FROM ROW DTL 432S-1/SHT DTL1 FOR ALL EXISTING UTILITY AND OIL/GAS PIPELINE LOCATIONS PRIOR TO BEGINNING ANY WORK. 2. CONTRACTOR TO COORDINATE EXISTING UTILITY STREET STA 18+91.56 INSTALL 10 FT BIKE LANE WITH TERRA COTTA RELOCATION & ADJUSTMENT TO GRADE WITH EX WW MH •133953 EX RIM=555.89 APPROPRIATE CITY AND PRIVATE UTILITY PROVIDERS. INTEGRATED PIGMENT PROPOSED RIM-558.40
ADJUST MANHOLE TO PROPOSED FINISHED GRADE (ADJUSTMENT DETAILS, SHEETS DTL2 AND DTL3) SCALE: STA 22+84.83 END NEW STRIET CONSTRUCTION 1"= 20' H BEGIN REPAVIN CITY OF AUSTIN 1"= 2' V 24.694 ACRES VOL. 10759 PG\ 488 STREET ILVERSTONE PH.1 SEC/2 UNNAMED TRIBUTARY
PR 100 YR FLOODPLAIN **CURVE DATA** BK. 78 PG. 383 **SOUNAWAY** USE 50' ASHLAND PIPE WARNING C3= R=750.00' HIGH-PRESSURE PIPELINE(S) ESMT D=26° 49'55'' A=351.23' Excavation and/or Construction Prohibited Texas Firm No. F-1114 26 GAS ESMT Without compliance with State One-Call AND TBPLS Firm No. 10065900 T - 178.90' WOOD/F Without Written Permission From 5707 Southwest Parkway C=348.03' VOL. 436 PG. 3 MAGELLAN PIPELINE COMPANY, L.P. CB=S05° 38'28"W Building 2, Suite 250 UNNAMED TRIBUTARY EX 100 YR FLOODPLAIN Austin, TX 78735 Phone: 512-306-8252 DRAINAGE EASEMENT 9.287 ACRES VOL. 8674 PG. 476 ISION 0 3 LAKE BLVD STREET EXTEN CIP# 6319.014 560 560 DOW LAKE PROFILE ST TO 22+35 - PROPOSED GRADE LINE 558 REPLACE SUBGRADE AND
BACKFILL WITH CLSM ITEM 402S
FOR 8FT WIDTH CENTERED ON
EXISTING PIPELINE K = 40FOR 8FT WIDTH CENTERED ON 100.00' V.C. 556 556 EXISTING PIPELINE MEADOW 554 EX GRD- 35'RT CL ∠−EX GRD- CL _EX GRD- 35'LT CL **552** _552 S ←EX GRD- CL 550 64918 — CONCRETE CAP DETAIL D/SHEET DTL4 `_asphalt 1" BASE 13" 548 PAVEMENT OVER CULVERT TO BE CONCRETE ITEM 360-NO BASE OR SUBGRADE 4/22/2020 **546 546** SITE PLAN APPROVAL APPLICATION DATE: 4/11/18 ILE NUMBER: <u>C8-2019-0080.1B.SH</u> IF THIS BAR DOES NOT MEASURE 1" THEN DRAWING **544** APPROVED BY COMMISSION ON: UNDER SECTION 112 OF CHAPTER 25-5 OF THE CITY OF AUSTIN CODE. IS NOT TO SCALE **1**2 EXPIRATION DATE (25-5-81, LDC) _____ CASE MANAGER: <u>DANIELLE GUEVARA</u> PROJECT EXPIRATION DATE (OED #970905-A) 22+84.83 NEW STREE IN REPAVING **542** rector, Development Services Department LEASED FOR GENERAL COMPLIANCE: STA 22+09.86
PROPOSED 3-9
BOX CULVERT UDG JOB NO. 17-935 Final plat must be recorded by the Project Expiration Date, if applicable. Subsequent Site STA END BEGIN C8-2019-0080.1B.SH lans which do not comply with the Code current at the time of filing, and all required Buildn 540 Permits and/or a notice of construction (if a building permit is not required), must also be 18+50 19+00 20+00 21+00 23+00 SHEET NUMBER | 15 OF 58 pproved prior to the Project Expiration Date.

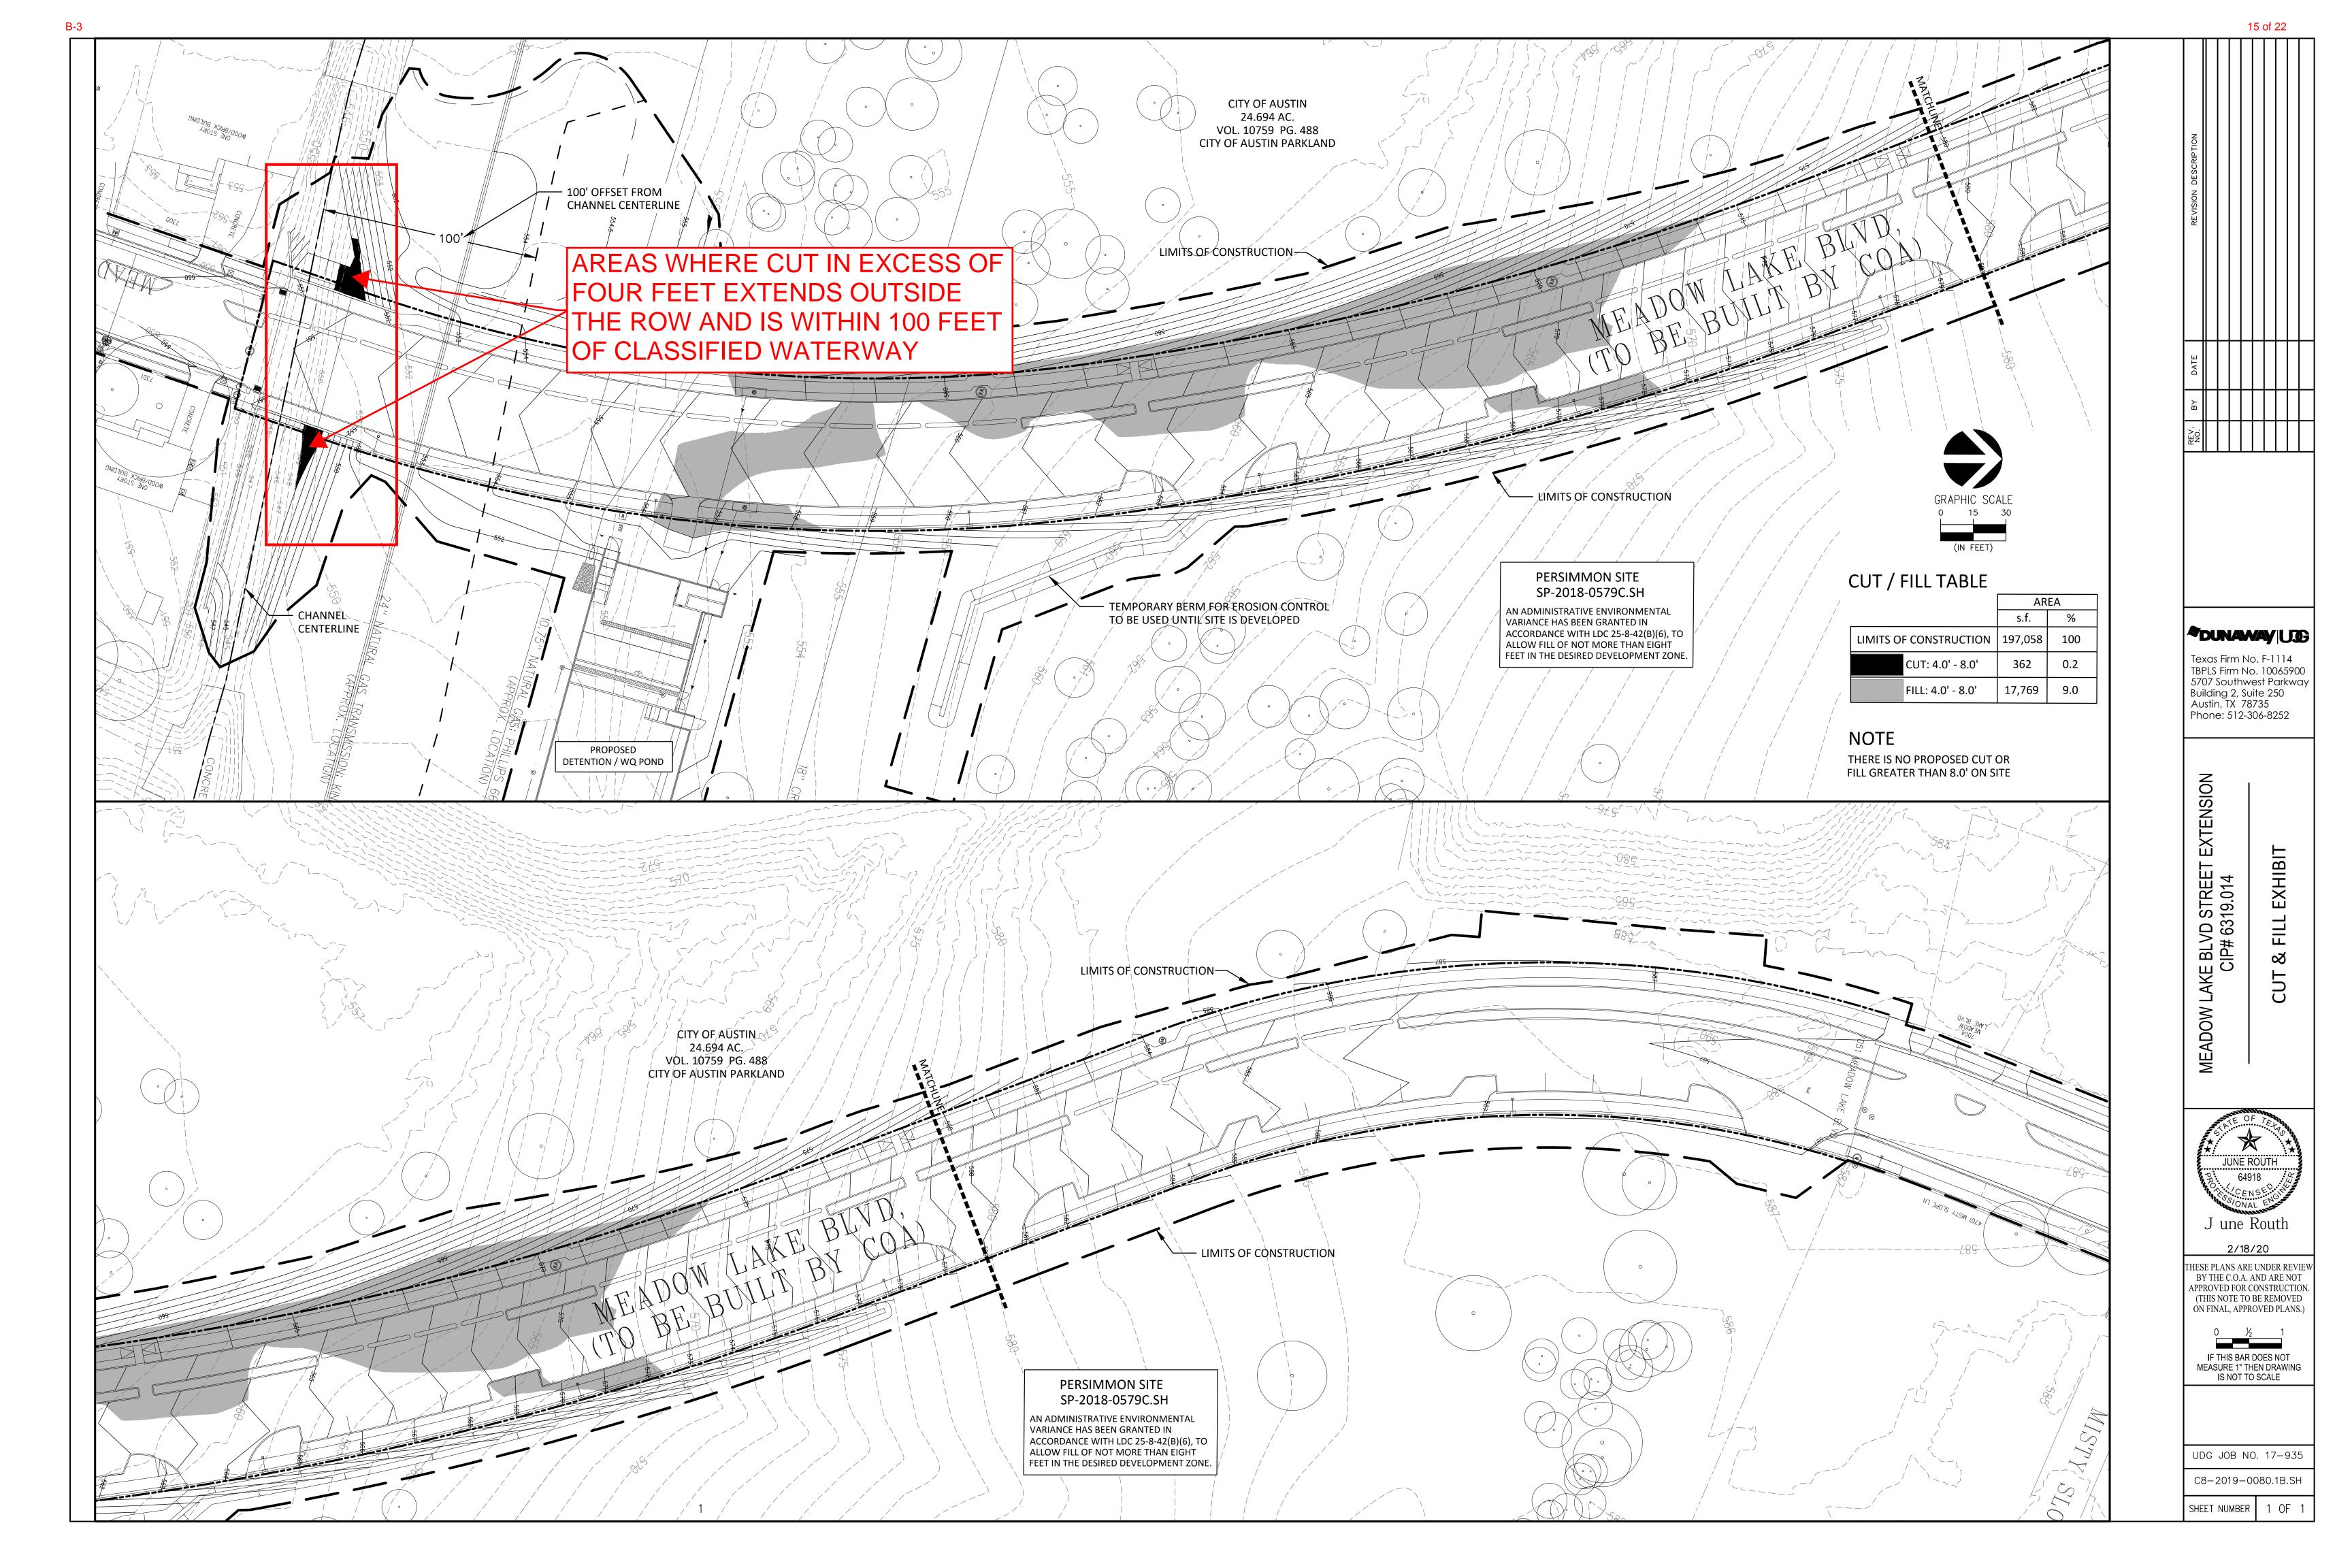

Meadow Lake Blvd. Stream Crossing and Restoration Concept



Project details:

-The proposed roadway extension of Meadow Lake Blvd. threatened to cause further damage and degradation to the classified waterway, furthering endangering the neighboring property owners in an underserved community.


Requirements for compliance:


- -Install energy dissipation device upstream and downstream to mitigate "rushing water" released from upstream detention pond;
- -Stabilize both sides of stream bank to prevent scour and erosion;
- -Install new drop structure to repair existing, broken infrastructure;
- -Install waterway crossing culverts at a depth that will allow for the 100-year flows to safely pass underneath the roadway without narrowing the channel width, increasing the velocity of flows coming out of the box culverts, and modifying downstream flow patterns; and,
- -Revegetate the stream channel with appropriate riparian vegetative stabilization plants and techniques.

17 of 22 1"= 20' H CITY OF AUSTIN 24.694 ACRES VOL. 10759 PG. 488 -50' ASHLAND PIPE LINE ESMT VOL. 3627 PG. 629 50' ASHLAND PIPE LINE ESMT VOL. 3627 PG. 629 \$33 **®DUNAWAY** USE Texas Firm No. F-1114
TBPLS Firm No. 10065900
5707 Southwest Parkway
Building 2, Suite 250
Austin, TX 78735
Phone: 512-306-8252 NOISN **N O** LAKE BLVD STREET EXTEN CIP# 6319.014 BANK RESTORAT INDEX MAP EROSION SHAZARD ZONE SILVERSTONE
PHASE -1 SECTION 1
BOOK 78 PAGE 381-382 SILVERSTONE
PHASE 1 SECTION 2
BOOK 78 PAGE 383-384 SILVERSTONE PHASE 1 SECTION 8 BOOK 78 PAGE 383-384 STREAM BLOCK J MEADOW Brock \D **PRELIMINARY DESIGN DOCUMENT** THIS DOCUMENT IS RELEASED FOR THE PURPOSE OF INTERIM REVIEW UNDER THE AUTHORITY OF JUNE ROUTH, P.E. 64918. IT IS NOT TO BE USED FOR CONSTRUCTION, BIDDING, OR FINAL PERMIT PURPOSES. 12/14/2020 SHEET <u>67</u> OF <u>72</u> SITE PLAN APPROVAL APPLICATION DATE: 4/11/18
UNDER SECTION 112 OF FILE NUMBER: <u>C8-2019-0080.1B.SH</u> IF THIS BAR DOES NOT MEASURE 1" THEN DRAWING IS NOT TO SCALE APPROVED BY COMMISSION ON: CHAPTER 25-5 OF THE CITY OF AUSTIN CODE. EXPIRATION DATE (25-5-81, LDC) CASE MANAGER: <u>DANIELLE GUEVARA</u> PROJECT EXPIRATION DATE (OED #970905-A) _____ DWPZ ____ DDZ _X SB1 Director, Development Services Department RELEASED FOR GENERAL COMPLIANCE: _ Correction 1: ___ UDG JOB NO. 17-935 Rev.3: ____ Correction 3: ____ Final plat must be recorded by the Project Expiration Date, if applicable. Subsequent Site C8-2019-0080.1B.SH Plans which do not comply with the Code current at the time of filing, and all required Building Permits and/or a notice of construction (if a building permit is not required), must also be SHEET NUMBER 67 OF 72 approved prior to the Project Expiration Date.

18 of 22 50' ASHLAND PIPE LINE ESMT — VOL. 3627 PG. 629 3 LAYERS OF LIMESTONE
BLOCK SLOPE STABILIZATION
EACH BLOCK- 2 FT HIGH, 3
FT WIDE, 4 FT LONG
DTL G/SHT SB7 INSTALL 6 BAFFLE PIERS SHEET SB7 FOR LAYOUT AND DETAILS TOP OF EXISTING CONCRETE CHANNEL LIMESTONE BLOCK SLOPE STABILIZATION DTL G/SHT SB7 **DUNAWAY** UJG Texas Firm No. F-1114
TBPLS Firm No. 10065900
5707 Southwest Parkway
Building 2, Suite 250
Austin, TX 78735
Phone: 512-306-8252 PROPOSED 3-BARREL 9'x4' CULVERT FL545.38 DRAINAGE EASEMENT
9.287 ACRES
VOL. 8674 PG. 476 FLEXAMAT WITH 609S GRASS SEED MEADOW LAKE BLVD STREET EXTENSION CIP# 6319.014 EXISTING CONCRETE 548. FLEXMAT TO TURN DOWN
1FT MINIMUM AT ALL EDGES SNVERSTONE 7.5' P.U.E. BK.78 PG.383 3 LAYERS OF LIMESTONE BLOCK SLOPE STABILIZATION EACH BLOCK- 2 FT HIGH, 3 FT WIDE, 4 FT LONG DTL G/SHT SB7 PHASE 1 SECTION 2 DTL K/SHT SB7 BOOK 78 PAGE 383-384 INSTALL TOE WALL DTL C/SHT SB7 LIMESTONE BLOCK SLOPE STABILIZATION DTL G/SHT SB7 SILVERSTONE PH. 1 SEC. 2 BK.\78 PG. 383 **PRELIMINARY DESIGN DOCUMENT** THIS DOCUMENT IS RELEASED FOR THE PURPOSE OF INTERIM REVIEW UNDER THE AUTHORITY OF JUNE ROUTH, P.E. 64918. IT IS NOT TO BE USED FOR CONSTRUCTION, BIDDING, OR FINAL PERMIT PURPOSES. 12/14/2020 SITE PLAN APPROVAL SHEET <u>68</u> OF <u>72</u> FILE NUMBER: <u>C8-2019-0080.1B.SH</u> APPLICATION DATE: 4/11/18 IF THIS BAR DOES NOT MEASURE 1" THEN DRAWING IS NOT TO SCALE UNDER SECTION 112 OF APPROVED BY COMMISSION ON: _ CHAPTER 25-5 OF THE CITY OF AUSTIN CODE. CASE MANAGER: DANIELLE GUEVARA EXPIRATION DATE (25-5-81, LDC) PROJECT EXPIRATION DATE (OED #970905-A) Director, Development Services Department RELEASED FOR GENERAL COMPLIANCE: UDG JOB NO. 17-935 __ Correction 3: _ Final plat must be recorded by the Project Expiration Date, if applicable. Subsequent Site C8-2019-0080.1B.SH Plans which do not comply with the Code current at the time of filing, and all required Building Permits and/or a notice of construction (if a building permit is not required), must also be SHEET NUMBER 68 OF 72 approved prior to the Project Expiration Date.

19 of 22 SOIL RETENTION BLANKET PER COA STANDARD SPECIFICATION 605S WITH DEEP ROOTED NON-WOODY VEGETATION VEGETATION SHALL BE 50% SWITCHGRASS, 50% BUSHY BLUESTEM, MINIMUM 1 GAL SIZE, MIN 3' SPACING DTL E/SHT SB7 5"-8" ROCK RIPRAP, 40 LF 2 LAYERS OF LIMESTONE BLOCK SLOPE STABILIZATION EACH BLOCK- 2 FT HIGH, 3 18" LAYER THICKNESS DTL 508S-19/SHT DTL1 - 50' ASHLAND PIPE LINE ESMT VOL. 3627 PG. 629 FT WIDE, 4 FT LONG DTL G/SHT SB7 LIMESTONE BLOCK SLOPE STABILIZATION DTL G/SHT SB7 DRAINAGE EASEMENT INSTALL TOE WALL DTL C/SHT SB7 REMOVE AND REPLACE CONCRETE RIPRAP DTL D/SHT SB7 **DUNAWAY** UJG PROPOSED 3-BARREL 9'x4' CULVERT - FL545.00 JOINT DETAIL FOR RIPRAP REPLACEMENT Texas Firm No. F-1114 TBPLS Firm No. 10065900 DTL H/SHT SB7 5707 Southwest Parkway Building 2, Suite 250 Austin, TX 78735 Phone: 512-306-8252 ----5-4---LAKE BLVD STREET EXTENSION CIP# 6319.014 G/9 SB7 LIMESTONE BLOCK SLOPE STABILIZATION DTL G/SHT SB7 7.5' P.U.E. BK.78 PG.383 3 LAYERS OF LIMESTONE BLOCK SLOPE STABILIZATION EACH BLOCK- 2 FT HIGH, 3 FT WIDE, 4 FT LONG DTL G/SHT SB7 LIMESTONE BLOCK SLOPE STABILIZATION DTL G/SHT SB7 MEADOW CONCRETE SILVERSTONE PHASE 1 SECTION 2 BOOK 78 PAGE 383-384 EROSION HAZARD ZONE **PRELIMINARY DESIGN DOCUMENT** THIS DOCUMENT IS RELEASED FO THE PURPOSE OF INTERIM REVIEW UNDER THE AUTHORITY OF JUNE ROUTH, P.E. 64918. IT IS NOT TO BE USED FOR CONSTRUCTION, BIDDING, OR FINAL PERMIT PURPOSES. 12/14/2020 SHEET <u>69</u> OF <u>72</u> SITE PLAN APPROVAL FILE NUMBER: <u>C8-2019-0080.1B.SH</u> APPLICATION DATE: 4/11/18 IF THIS BAR DOES NOT MEASURE 1" THEN DRAWING IS NOT TO SCALE UNDER SECTION 112 OF APPROVED BY COMMISSION ON: CHAPTER 25-5 OF THE CITY OF AUSTIN CODE. EXPIRATION DATE (25-5-81, LDC) ___ CASE MANAGER: DANIELLE GUEVARA PROJECT EXPIRATION DATE (OED #970905-A) SB3 Director, Development Services Department RELEASED FOR GENERAL COMPLIANCE: Correction 1: ___ UDG JOB NO. 17-935 _ Correction 3: _ Final plat must be recorded by the Project Expiration Date, if applicable. Subsequent Site C8-2019-0080.1B.SH Plans which do not comply with the Code current at the time of filing, and all required Buildin Permits and/or a notice of construction (if a building permit is not required), must also be SHEET NUMBER 69 OF 72 approved prior to the Project Expiration Date.

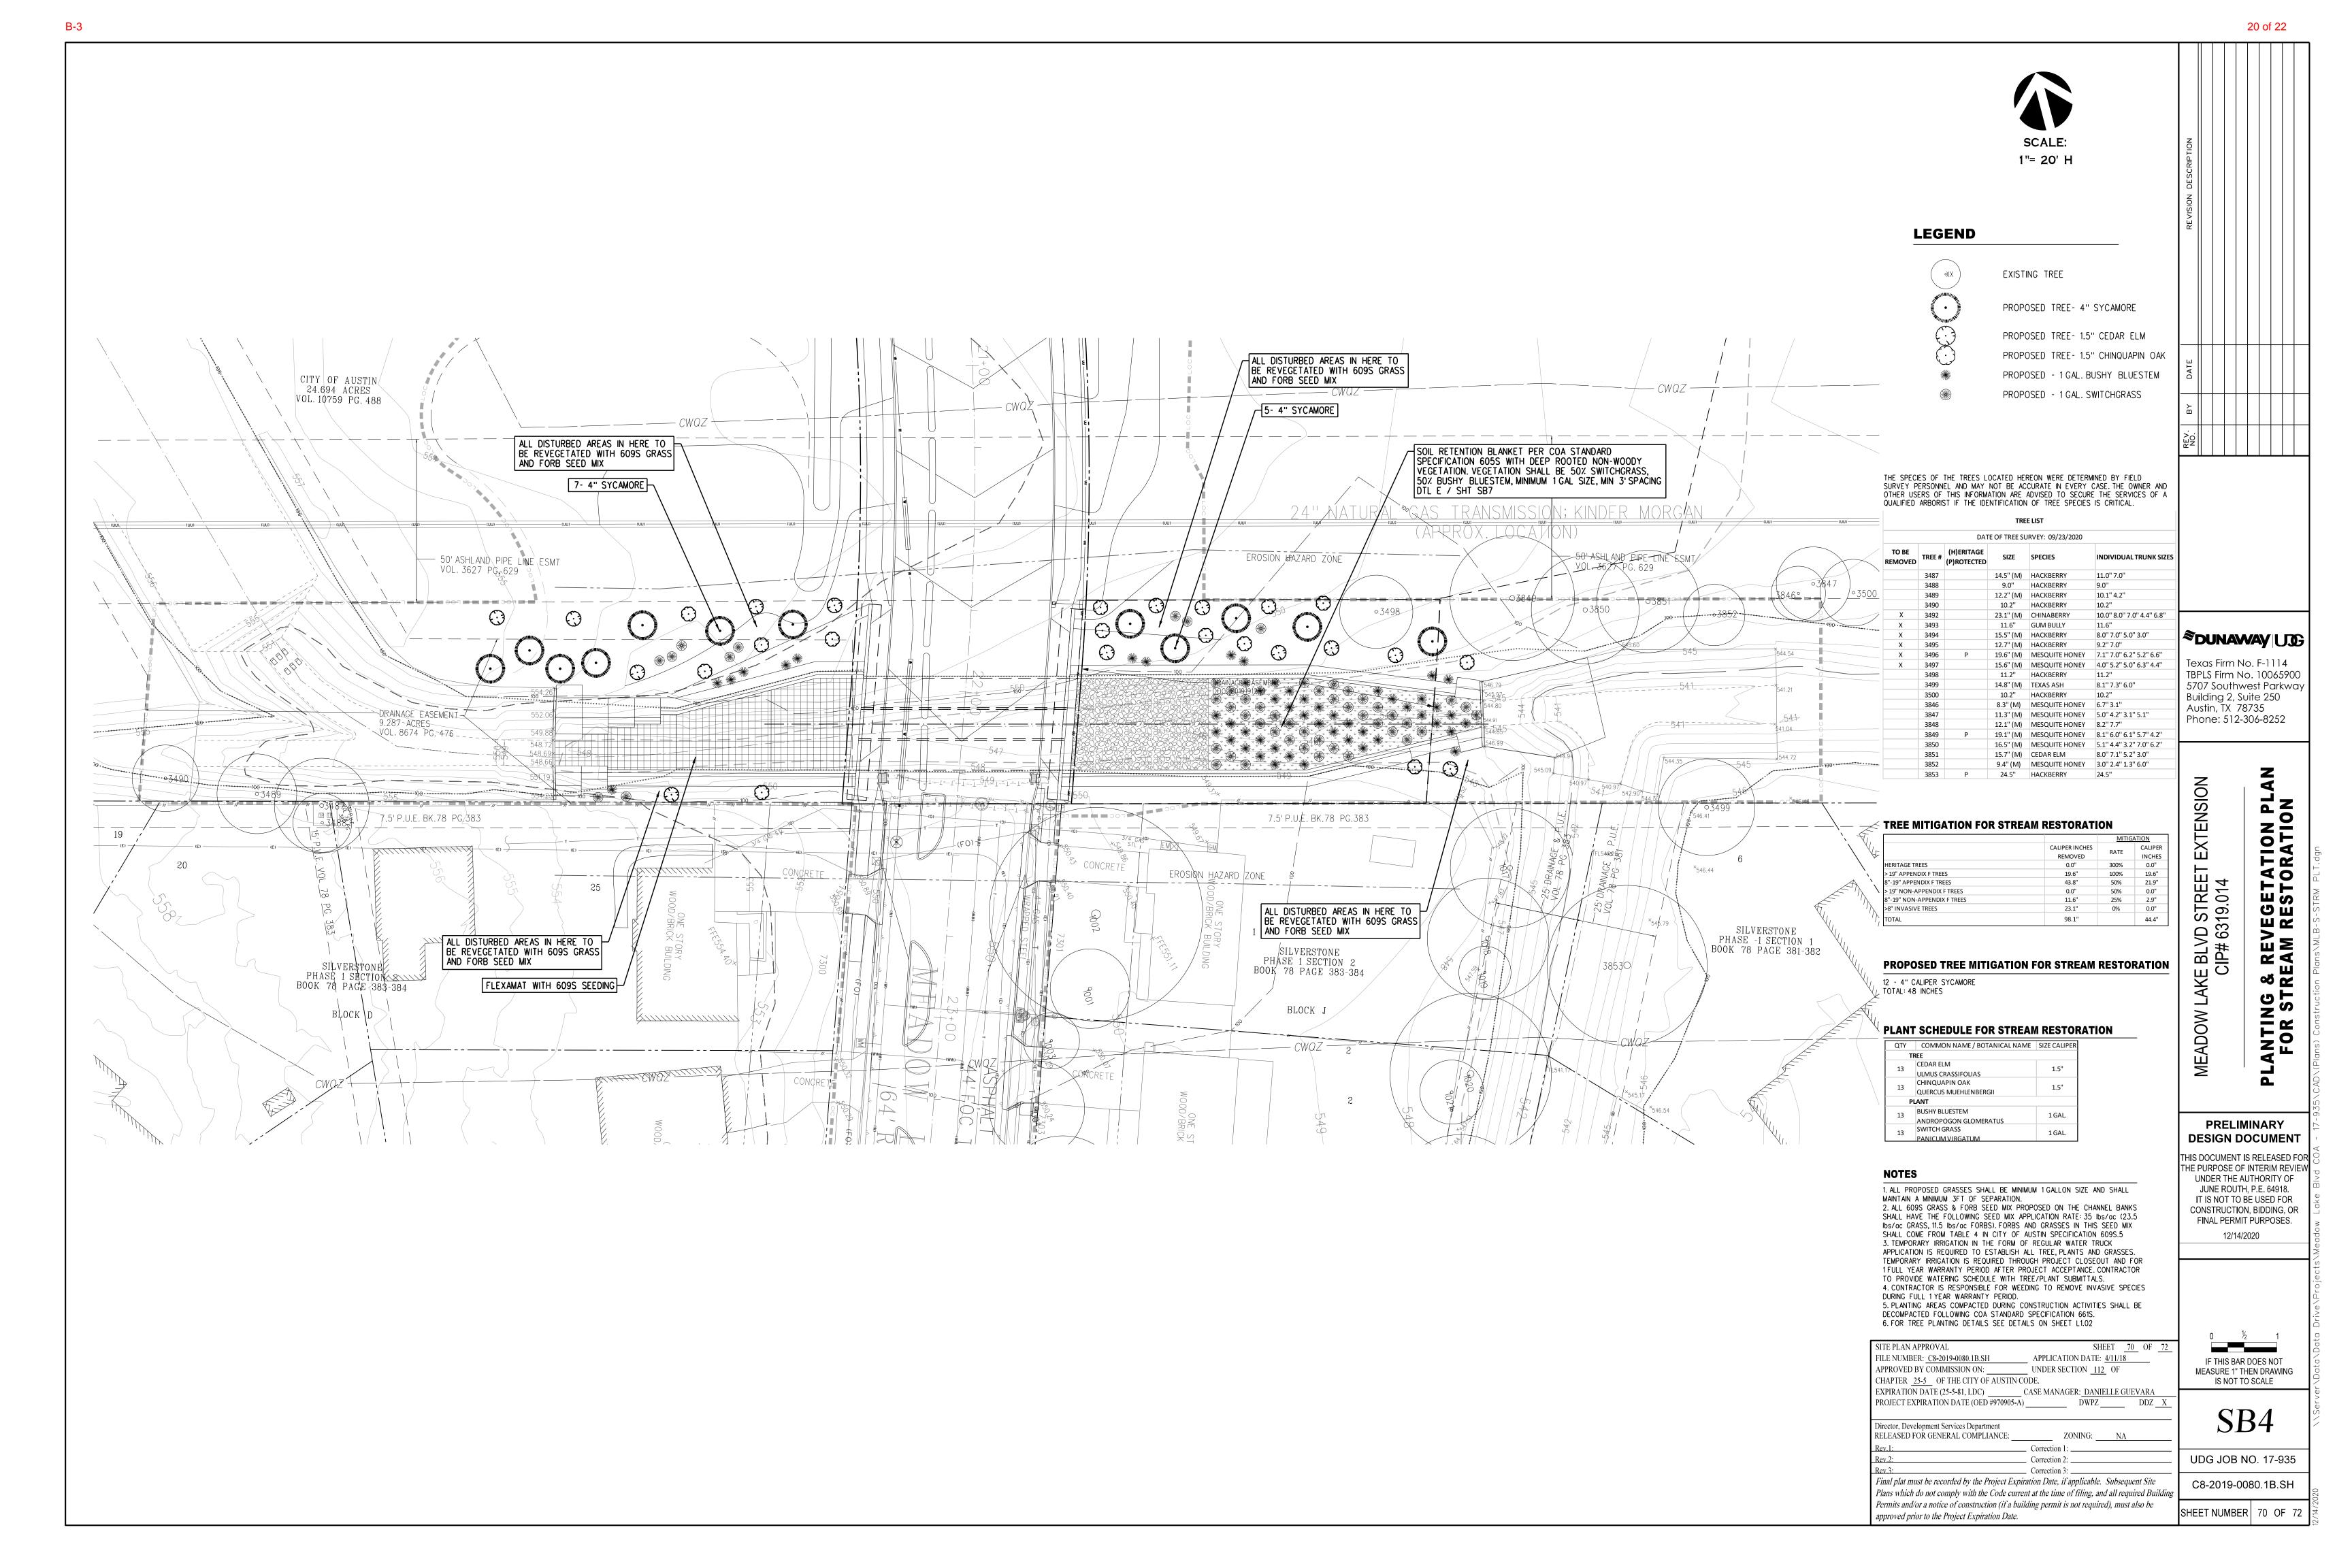

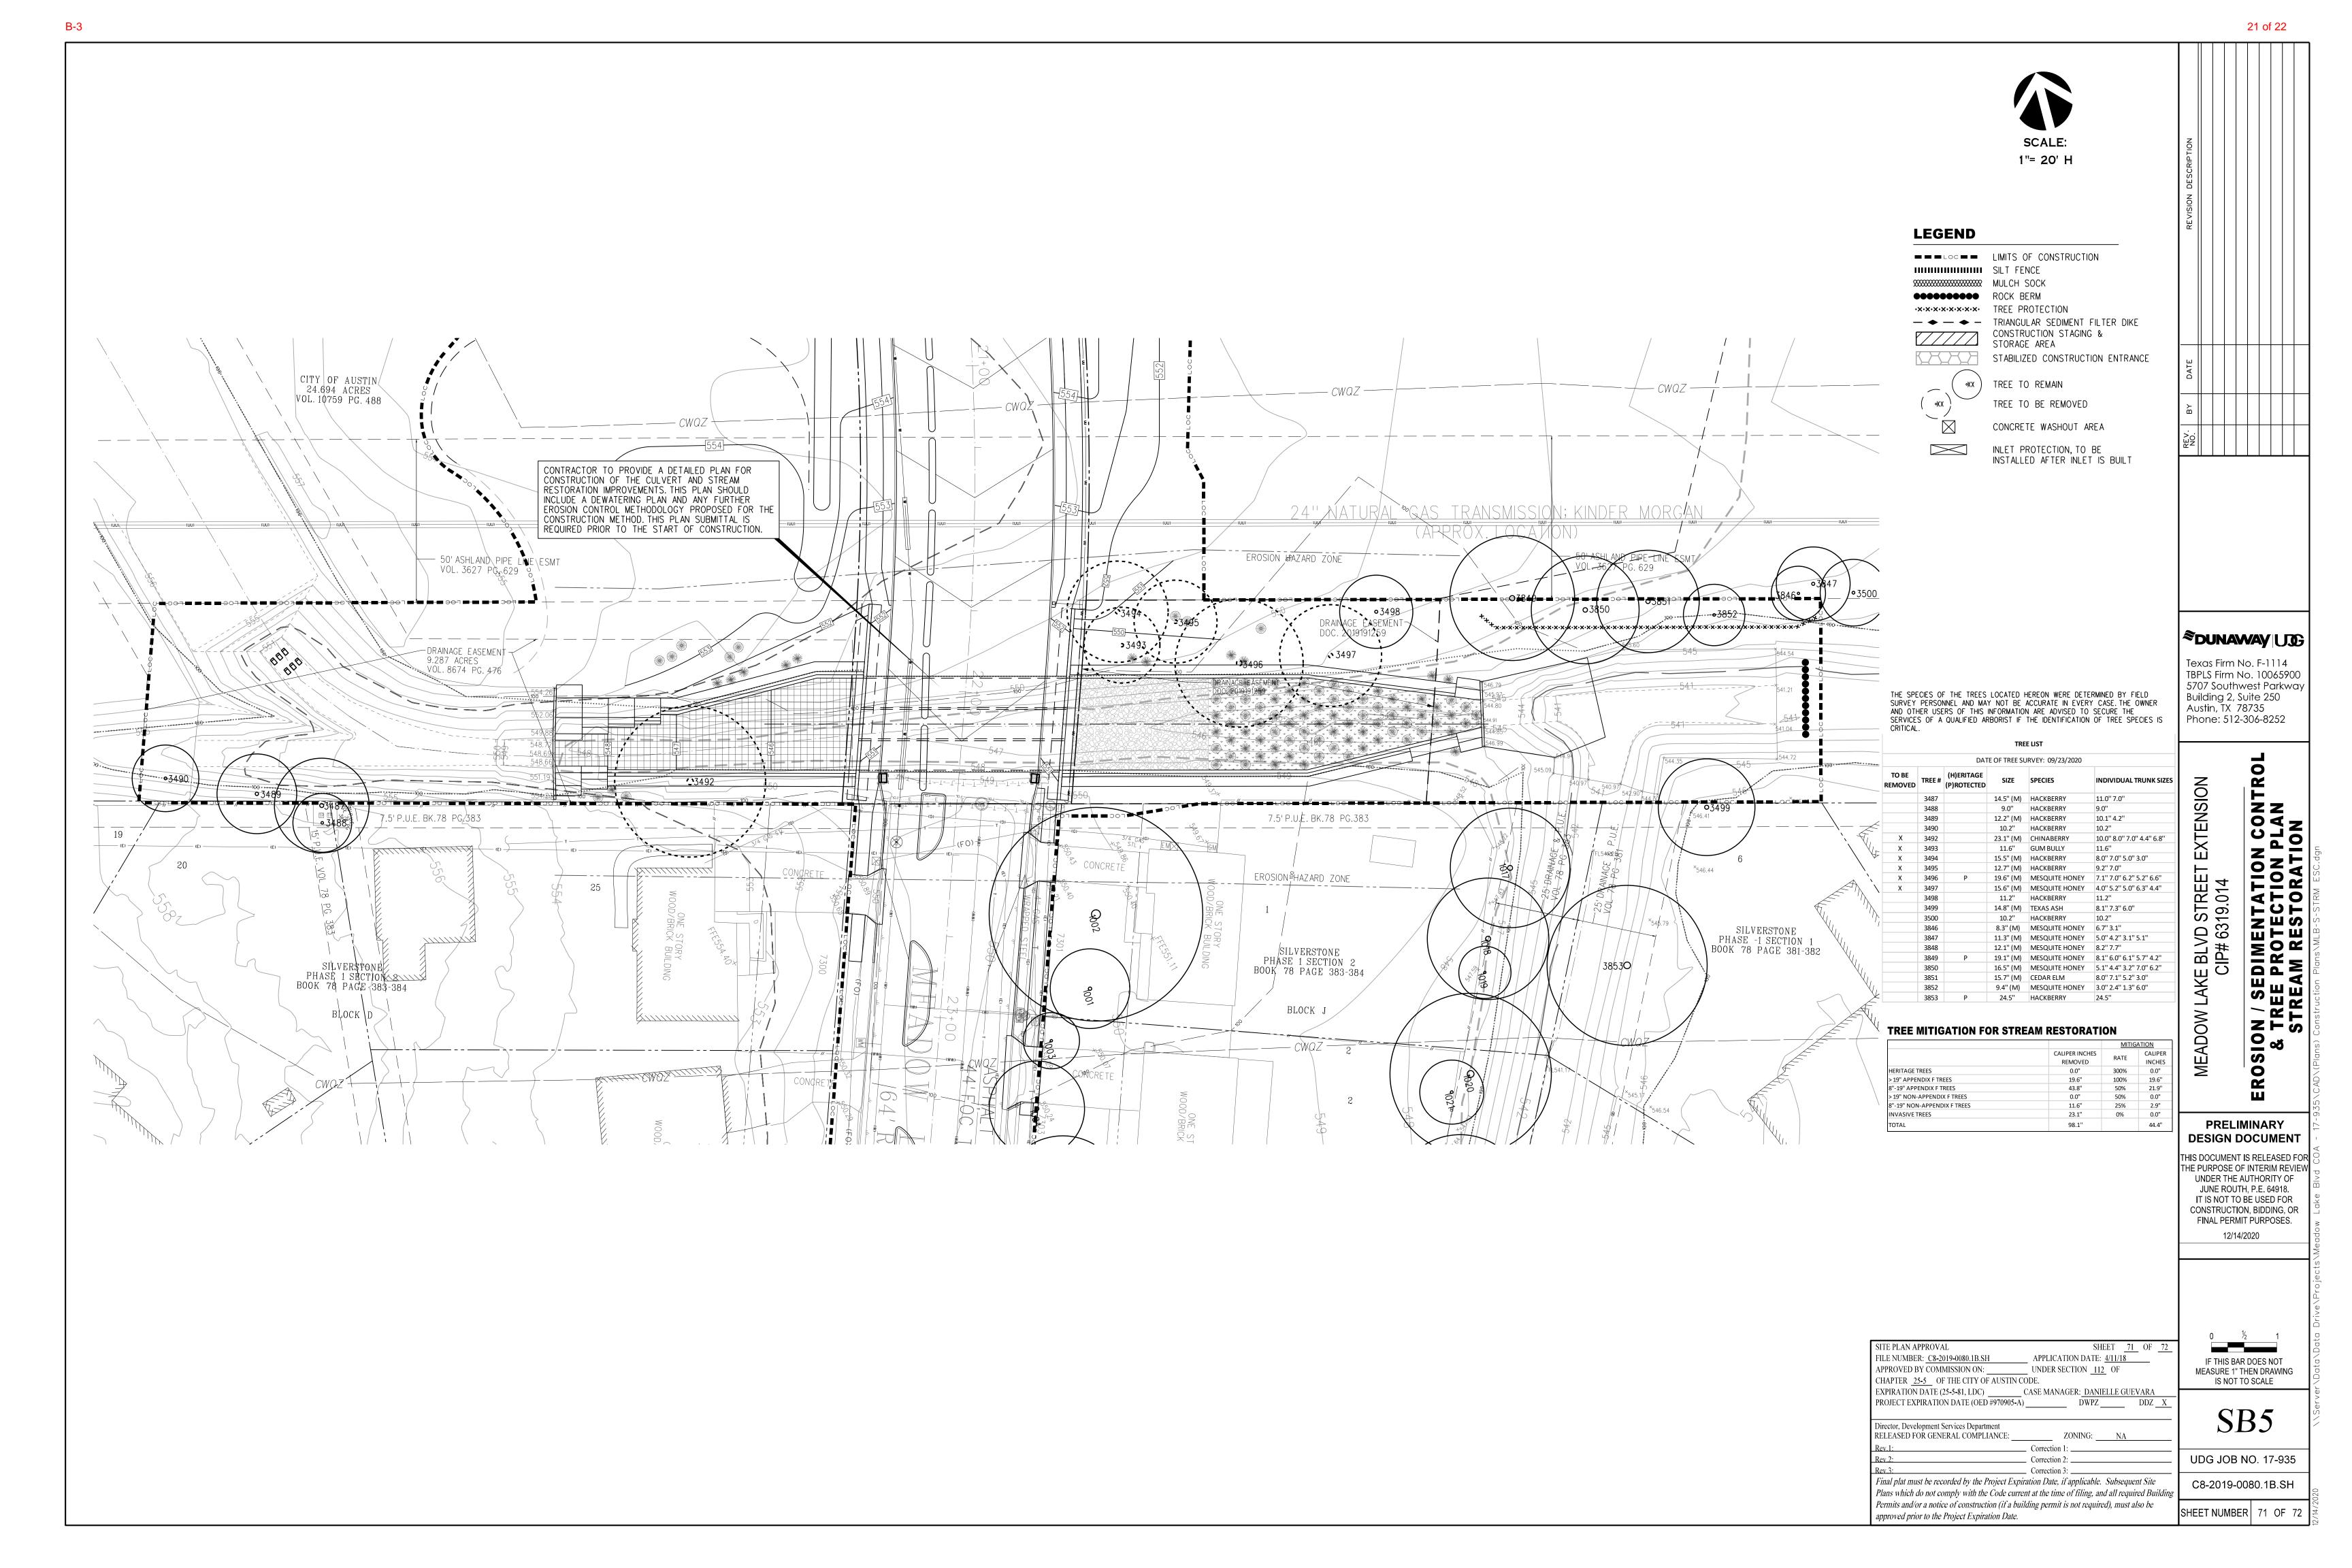

22 of 22 B-3 — TIE BARS AS REQ'D GRADE BREAK +4 DOWELS 2 PER FACE (8 TOTAL PER PIER) -LOW MODULUS SILICONE OR POLYURETHANE JOINT SEALER 7" 13.5" 13.5" 13.5" 13.5" 13.5" PER COA ITEM 413.5 - 3/4" POLYPROPYLENE — BAFFLE PIER DETAIL A JOINT FILLER, NOMAFLEX OR EQ 3/4" CHAMFER ─ - EPOXY DOWEL IN PLACE EXISTING CONCRETE RIPRAP - CLASS A CONCRETE 4"-6" SLUMP - *5 BARS CONTINUOUS CONCRETE RIPRAP CONCRETE RIPRAP — COMPACT ANY
DISTURBED SOIL *4 DOWELS 2 PER FACE (8 TOTAL PER PIER) © ADDITIONAL TOE WALL DETAIL NOT TO SCALE A BAFFLE PIER DETAIL NOT TO SCALE BAFFLE PIER LAYOUT NOT TO SCALE **DUNAWAY** USE Texas Firm No. F-1114 TBPLS Firm No. 10065900 — SHEAR PIN, TYP SEE DTL J 5707 Southwest Parkway — EXISTING CONCRETE RIPRAP -7/8" DRILLED HOLE Building 2, Suite 250 Austin, TX 78735 - ORGANIC TOPSOIL, TYP SEE DTL J → *6 GRADE 60 DEFORMED Phone: 512-306-8252 REBAR 6" LONG -MATCH LINE & GRADE TO EXISTING --LIMESTONE ROCK FACES - EROSION BLANKET -INSTALL PER MANUFACTURER'S -FILTER FABRIC - MATCH WIDTH TO EXISTING SEE DTL J EXTENSION SPECIFICATIONS - GRAVEL, TYP FOLD THE CUT FABRIC -FILL VOID PARTLY (70%) WITH SEE DTL J UNDER & TACK DOWN QUICKCRETE HIGH STRENGTH ANCHORING EPOXY OR APPROVED EQUAL - CONCRETE FOOTING, TYP TOE WALL ALL SIDES ADJACENT TO SOIL HON — CUT AN 'X' THROUGH THE FABRIC & DIG A PLANTING HOLE SHEAR PIN DETAIL NOT TO SCALE NOTE: SOIL RETENTION BLANKET MATERIAL SHALL BE BIODEGRADABLE (NO PLASTIC ALLOWED) -- *****4 BARS @ 12" OCEW / LAKE BLVD STREET E CIP# 6319.014 AM RESTORAT DETAILS 1. CLASS C CONCRETE 2. GRADE 60 REINFORCING STEEL -6" CLASS C CONCRETE COA ITEM 403 -SHEAR PIN, 2 PER BLOCK, TYP SEE DTL ÁBOVE PLANTING IN SOIL RETENTION BLANKET

SCALE: NTS ∕ JUTE SOIL RETENTION BLANKET DOWNSTREAM CONCRETE RIPRAP REPLACEMENT
NOT TO SCALE - ORGANIC TOPSOIL 12" MIN DEPTH -FILTER FABRIC COA ITEM 620S GRADE AT CHANNEL REA - MATCH EXCAVATED SLOPE LOW MODULUS SILICONE OR POLYURETHANE JOINT SEALER PER COA ITEM 413.5 TCS 066 CRUSHED STONE GRAVEL MEADOW NOTE: EXCAVATE NARROW SLOT IN -WHICH FLEXAMAT IS INSERTED. GROUT ANNULAR SPACE TO SECURE IN PLACE. ← 3/4" POLYPROPYLENE JOINT FILLER, NOMAFLEX OR EQUAL FINISH GRADE AT CHANNEL, TYP.

MATERIAL VARIES, SEE PLAN 4' FLEXAMAT -CLASS A CONCRETE FOOTING ON COMPACTED SOIL BASE → NEW RIPRAP ✓ EX RIPRAP → 3' MIN EPOXY DOWEL IN PLACE

*4 @ 12" OC LIMESTONE BLOCKS FLEXAMAT TO TURN DOWN 1FT WHERE — ADJACENT TO PROPOSED LIMESTONE BLOCK AND/OR CONCRETE TYPICAL LIMESTONE BLOCK SLOPE STABILIZATION DETAIL- TIGHT CONFIGURATION PRELIMINARY **DESIGN DOCUMENT** ─SAW CUT JOINT SAW CUT SURFACES
TOP & BOTTOM
OTHER SURFACES
MAY BE SPLIT FACE THIS DOCUMENT IS RELEASED FOR 1. CLASS A CONCRETE 2. GRADE 60 REINFORCING STEEL THE PURPOSE OF INTERIM REVIEW UNDER THE AUTHORITY OF JOINT DETAIL AT DOWNSTREAM JUNE ROUTH, P.E. 64918. H CONCRETE RIPRAP REPLACEMENT
NOT TO SCALE IT IS NOT TO BE USED FOR CONSTRUCTION, BIDDING, OR K FLEXAMAT TURN DOWN DETAIL NOT TO SCALE FINAL PERMIT PURPOSES. 12/14/2020 TYPICAL LIMESTONE BLOCK SECTION LIMESTONE BLOCK SLOPE G STABILIZATION STACK ASSIGNMENT NOT TO SCALE SITE PLAN APPROVAL SHEET <u>72</u> OF <u>72</u> APPLICATION DATE: 4/11/18 FILE NUMBER: C8-2019-0080.1B.SH IF THIS BAR DOES NOT UNDER SECTION 112 OF APPROVED BY COMMISSION ON: MEASURE 1" THEN DRAWING CHAPTER 25-5 OF THE CITY OF AUSTIN CODE. IS NOT TO SCALE EXPIRATION DATE (25-5-81, LDC) ___ CASE MANAGER: DANIELLE GUEVARA PROJECT EXPIRATION DATE (OED #970905-A) SB7 Director, Development Services Department RELEASED FOR GENERAL COMPLIANCE: Correction 1: ____ UDG JOB NO. 17-935 __ Correction 3: _ Final plat must be recorded by the Project Expiration Date, if applicable. Subsequent Site C8-2019-0080.1B.SH Plans which do not comply with the Code current at the time of filing, and all required Buildin Permits and/or a notice of construction (if a building permit is not required), must also be SHEET NUMBER 72 OF 72 approved prior to the Project Expiration Date.